



Existing - Huddersfield Viaduct MVL3/92 - East Elevation

Scale 1:200

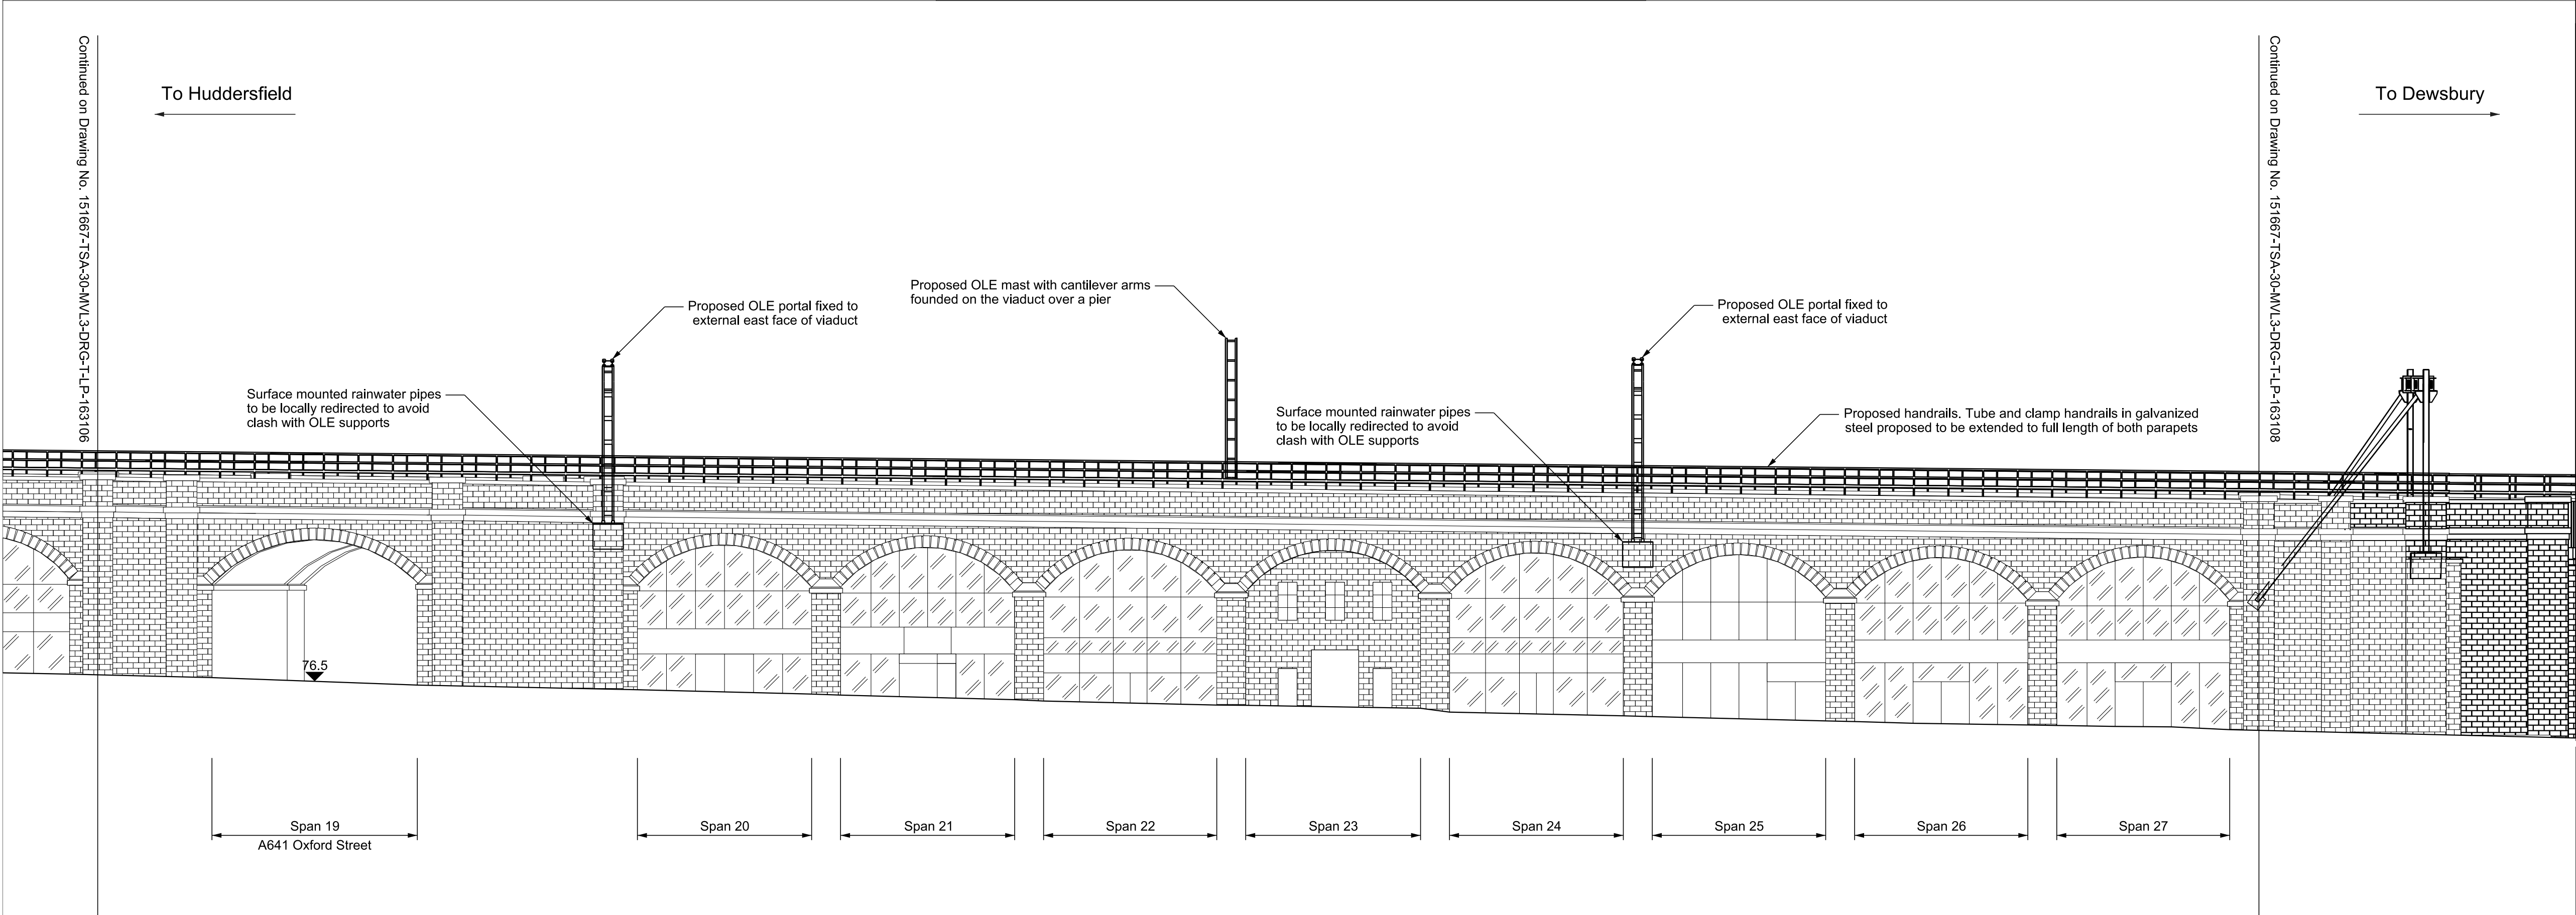

Proposed - Huddersfield Viaduct MVL3/92 - East Elevation


Scale 1:200

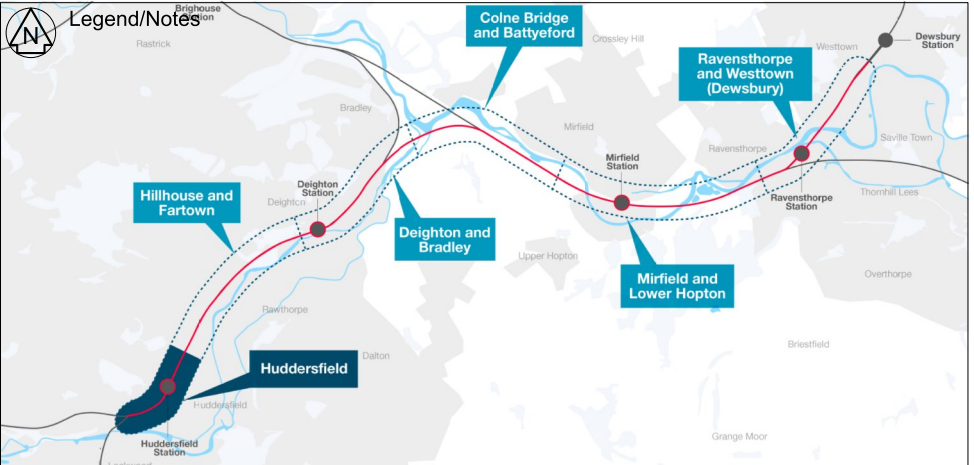

Legend

Listed Building Consent Application Boundary

- Notes
- All dimensions are in millimetres unless stated otherwise.
  - Do not scale from this drawing.
  - In constructing or maintaining the works identified as Scheduled Works in Schedule 1 of the Network Rail (Huddersfield to Westtown (Dewsbury) Improvements) Order Network Rail may deviate from the dimensions shown on this drawing to the extent permitted by the Order.
  - Overhead Line Equipment wires omitted for clarity.
  - This drawing is to be read in conjunction with drawings 151667-TSA-30-MVL3-DRG-T-LP-163100 to 151667-TSA-30-MVL3-DRG-T-LP-163106, drawings 151667-TSA-30-MVL3-DRG-T-LP-163108 to 151667-TSA-30-MVL3-DRG-T-LP-163115 and drawings 151667-TSA-30-MVL3-DRG-T-LP-163118 to 151667-TSA-30-MVL3-DRG-T-LP-163119.

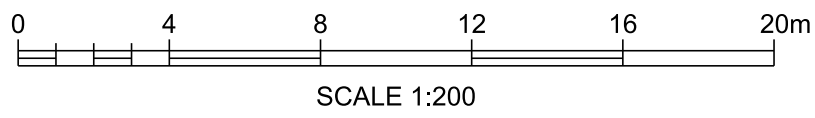

SCALE 1:200

THE NETWORK RAIL (HUDDERSFIELD TO WESTTOWN (DEWSBURY) IMPROVEMENTS) ORDER

P01	15/03/21	First Issue	DW	RF	GT
Rev	Date	Description of Revisions	Drawn	Chkd	Appr
Status					Suitability
Fit for Contractor Design					D3



Authorised T.Rivero Signed Electronically Signed Date 2021/03/15

Contractor(s) TRU West Alliance

Location STALYBRIDGE STN - HEATON LODGE JN (HUDD-MANC LINE)

Type CAD Drawing	Sub-type Elevation
Role Town and Country Planner	Sub-Role General
Zone Huddersfield	
Phasing Existing	Grip Stage 0
Project	

Transpennine Route Upgrade

Contract No. 151667

Contract Title West of Leeds

Drawing Title Listed Building Consent Drawing Huddersfield Viaduct MVL3/92 Existing and Proposed East Elevation

Designed	M.Colman	Signed	15/03/21
Drawn	D.Wilcox	Signed Electronically Signed	Date 15/03/21
Checked	R.Fletcher	Signed Electronically Signed	Date 15/03/21
Approved	G.Thomas	Signed Electronically Signed	Date 15/03/21
Scale(s)	1:200	ELR & Mileage 25.1504 to 0	
Alternative Reference		Sheet 3 of 5	Revision
Drawing Number	151667-TSA-30-MVL3-DRG-T-LP-163107		P01